14-38 COWPER ST, 21-41 EAST ST, 5-5A ROWELL ST GRANVILLE NSW 2142 PUBLIC DOMAIN CIVIL WORKS



DEVELOPMENT APPLICATION

	IMPORTANT NOTES: Do not scale from drawfigs: All dimensions shall be checked on afte before commencement of work. All discrepancies whall be brought for the attention of the Architect. Large scale and the scale of the scale of the architect and	B C	2016.11 2016.11 2016.11	DESCRIPTION 11.15 PRELIMINARY ISSUE FOR COORDINATION 11.16 DEVELOPMENT APPLICATION 11.17 DEVELOPMENT APPLICATION 2.03 DEVELOPMENT APPLICATION	BY LP LP LP	marchese partners Marchese Partners Engineering Pty Ltd	NM	DPG PROJECT 7 PTY LTD	TITLE SHE LOCALITY			
-	DEVELOPMENT					Level 1, 53 Walker Striet, North Sydney, NSW 2060, Australia P +61 2 9922 4375 F +61 2 9929 5786 E Info@marchesepartners.com.au www.marchesepartners.com.au Sydney & Brisbane - Canthera - Melbourne - Adelalde - Perth		PROJECT 14-38 COWPER ST, 21-41 EAST ST, 5-5A ROWELL ST GRANVILLE NSW 2142	SCALE NTS@A1 NTS@A3	DATE 10.11.2016	DRAWN TF	CHECKED
	APPLICATION					Kuala Lumpur - Auckland ABN 32 604 104 378		5-5A ROWELL ST GRANVILLE NSW 2142	лов 0991	DA-C-001		D

LEGEND LINETYPES HYDRAULIC SERVICES SYMBOLS BOUNDARY VERTICAL RISER IN DRAINAGE _____ EASEMENT CLEAROUT OR INSPECTION OPENING DTU _____/ ____/ _____ FENCE DRAINAGE TURN-UP OVERFLOW FLOW DIRECTION ARROW - RAINWATER RE-USE PENETRATION CORE THROUGH STRUCTURAL ELEMENT SIPHONIC DRAINAGE O_{DP 150} DOWNPIPE (150mm DIAMETER) SUBSOIL DRAINAGE RISER SUBSOIL RISING MAIN DROPPER STORMWATER DRAINAGE DROPS TO BELOW / RISES FROM BELOW STORMWATER RISING MAIN CAPPED OFF SERVICE STORMWATER DRAINAGE CONTINUATION OF SERVICE NOT SHOWN — GREASE WASTE CONTINUATION OF SERVICE SHOWN FI SEWHERE FLANGED CONNECTION ----scv---scv- SEWER CHAMBER VENT SERVICE CAST IN SLAB GRAVITY SEWER / SANITARY DRAINAGE SERVICE CONCRETE ENCASED SEWER PUMPOUT æ GAS REGULATOR SEWER RISING MAIN **a TRADE WASTE DRAINAGE VENTED GAS REGULATOR ----TWV----TWV- TRADE WASTE VENT 凰 UTILITY REGULATOR DESEL EXHAUST S FIRE HYDRANT SOLENOID VALVE FIRE HYDRANT PRESSURE GAUGE ISOLATION VALVE FIRE HOSE REEL M BALANCING VALVE (STAD) FIRE SPRINKLER CHECK VALVE COLD WATER BACKFLOW PREVENTION DEVICE FILTERED RAINWATER RE-USE PRESSURE LIMITING VALVE HOT WATER FLOW PRESSURE REDUCTION VALVE HOT WATER RETURN STRAINER METER NON-POTABLE COLD WATER THEMOSTATIC MIXING VALVE RECYCLED COLD WATER (F) FILTER WARM WATER FLOW ----- WARM WATER RETURN HOSE TAP NATURAL GAS COLD WATER POIN MEDICAL GASES - COMPRESSED AIR HOT WATER POINT - MEDICAL GASES - CARBON DIOXIDE FIRE HYDRANT MEDICAL GASES - NITROUS OXIDE DOUBLE PILLAR FIRE HYDRANT STANDPIPE - MEDICAL GASES - OXYGEN FIRE HOSE REEL ELECTRICAL WIRING ® PRESSURE GAUGE - ELECTRICAL CONDUIT Ō TEMPERATURE GAUGE THRUST BLOCK SERVICES & UTILITIES ¤B⊺ BOUNDARY TRAF EXISTING ELECTRICAL om IPME INDUCT PIPE MICA FLAP - EXISTING GAS **⊠** ORG OVERFLOW RELIEF GULLY EXISTING OIL TUNDISH — EXISTING TELSTRA WATER CLOSET (S-TRAP) — EXISTING SEWER WATER CLOSET (P-TRAP) — EXISTING STORMWATER BASIN - EXISTING WATER SINK -X - A - X - A - X - A - X - A - EXISTING SERVICE TO BE ABANDONED ~~ DV DISHWASHER NOTE: 'e' ON SERVICE LINE DENOTES EXISTING SERVICE. 'X' ON SERVICE LINE DENOTES SERVICE TO BE ABANDONED. FLOOR WASTE gm BTFV BUCKET TRAP FLOOR WASTE N RV **EROSION & SEDIMENT SYMBOLS** REFLUX VALVE AIR ADMITTANCE VALVE BARRIER FENCE O^{SME} SEWER MANHOLE (CAC) -×----× SILT FENCE ─ TOP OF BATTER Ø GREASE ARRESTOR RAINWATER OUTLET STABALISED CONSTRUCTION SITE III RWO SQUARE RAINWATER OUTLET VEHICLE ENTRY/EXIT GRID SPREADER RAINWATER HEAD STRAW BALE SEDIMENT FILTER SWP STORMWATER PIT (ACCESS ONLY) DRAWING INFORMATION SYMBOLS STORMWATER PIT (INLET) SCALE 1:100 KERB ENTRY PIT mm GTC GRATED TRENCH DRAIN DRAWING REFERENCE No FALL ARROW - DETAIL No. \Rightarrow OVERLAND FLOW PATH DIRECTIONAL ARROW 401 - DRAWING REFERENCE No. STORMWATER HEADWALL 0000 SWALE OR SPEED HUMP AMENDMENT REFERENCE CP. ELECTRICAL CONTROL PANEL DIRECTION OF ELOW ABBREVIATIONS, SYMBOLS AND LINETYPES IN - SERVICE THE LEGEND MAY NOT APPEAR ELSEWHERE ON THE DRAWINGS. THIS LEGEND SHOULD BE - SIZE USED AS A GUIDE ONLY

GENERAL ABBREVIATIONS

AIR ADMITTANCE VALVE ACCESSIBLE BASIN AIR CONDITIONING AIR RELEASE VALVE ACCESSIBLE TOILET (WATER CLOSET) BASIN BOX GUTTER BOX GUTTER OUTLET BOUNDARY TRAP BUCKET TRAP FLOOR WASTE BOILING WATER UNIT CIRCULAR ACCESS CHAMBER
CHAMBER VENT PIPE
CENTRES
CENTRE LINE CHVP CAST IRON CAST IN COLUMN CAST IN SLAB CLEAR OUT COPPER COLD WATER DUCTILE IRON DIAMETER DOUBLE PILLAR FIRE HYDRANT DRAINAGE STACK DRAINAGE TURN-LIF DRAWING ELEVATED DRAINAGE EXISTING GROUND LEVEL EAVES GUTTER OUTLET EXPANSION JOINT EXISTING FINISHED FLOOR LEVEL FIRE HYDRAN FIRE HOSE REEL FIRE HUSE REEL FIRE STOP COLLAR FLOOR WASTE GALVANISED GRATED DRAIN OUTLET GMS GVP HD HDC HDG HDPE GALVANISED MILD STEEL GREASE VENT PIPE HEAVY DUTY HEAVY DUTY COVER HEAVY DUTY GRATE HEAVY DUTY GRATE
HIGH DENSITY POLYETHYLENE
HIGH LEVEL
HIGH POINT
HOSE TAP HOT WATER HOT WATER UNIT INTERNAL DIAMTER INVERTIEVE

INVERTILEVEL
INSPECTION OPENING
INDUCT PIPE MICA FLAP
KERB ENTRY PIT
KITCHEN FLOOR WASTE

KEY OPERATED

LOW LEVEL

NATURAL GAS

NOMINAL

NUMBER

REVISION

REFLUX VALVE

RAINWATER HEAD

RAINWATER OUTLET

NOT IN CONTRACT

NUMBER
NOT TO SCALE
OUTSIDE DIAMETER
OVERFLOW
OVERFLOW RELIEF GULLY
PENETRATION

PRESSURE LIMITING VALVE

PRESSURE REDUCING VALVE

REVISION
REDUCED LEVEL
RAINWATER OUTLET
REDUCED PRESSURE ZONE DEVICE
RECESSED STOP TAP
RECESSED TUNDISH

LIGHT DUTY COVER

LIGHT DUTY GRATE

LOW LEVEL LIMIT OF CONTRACT MAXIMUM MINIMUM NOMINAL BORE

GDO

IO IPMF KEP KFW

LDC LDG LL L.O.C MAX MIN NB NG N.I.C

No. NTS OD O/F ORG

PLV

REV RL RO RPZE RST RTD

GENERAL ABBREVIATIONS CONT.

SHOWER

SEWER MANHOLE SMH SQ SST STD STD STW SV SWP TBC SOIL STACK SOIL STACK
STOP TAP
STANDARD
STORMWATER
STOP VALVE (ISOLATION VALVE) TO BE CONFIRMED. TD TG TMV TOK TTD TWL TWVP TRENCH GRATE
THERMOSTATIC MIXING VALVE
TOP OF KERB
TRAPPED TUNDISH TOP WATER LEVEL TRADE WASTE VENT PIPE UNO UNLESS NOTED OTHERWISE UNPLASTICISED POLYVINYL CHLORIDE UTENSIL WASHING MACHINE VANITY BASIN / VACCUM BREAKER VERTICAL VENT PIPE TOILET SUITE (WATER CLOSET) WASTE STACK

CIVIL ABBREVIATIONS

DRAINAGE LEVELS BOTTOM WATER LEVEL INVERT LEVEL OBVERTLEVEL MEDIUM DUTY CLASS 'C HEAVY DUTY CLASS 'D' EXTRA HEAVY DUTY CLASS 'E' MULTI PART COVER OR GRATE PITS DISCHARGE CONTROL PIT JUNCTION PIT KEP KERB ENTRY PIT CLEAROUT DOWN PIPE FLUSHING POINT
INSPECTION OPENING
GUTTER OVERFLOW PIPE
RAINWATER OUTLET
DRAINAGE TURNUP

CATCHMENT ABBREVIATIONS

LITRES PER SECOND m/s METRES PER SECOND
CUMECS CUBIC METRES PER SECOND
Q QUANTITY OF FLOW

DRAWING NOTES

DTII

- DRAWINGS ARE DIAGRAMMATIC ONLY FOR DIMENSIONS AND CONSTRUCTION DETAILS OF BUILDING REFER ARCHITECTURAL DRAWINGS AND
- 2. PIPEWORK SIZES ARE NOMINAL BORE FOR COPPER AND CAST IRON AND INTERNAL BORE FOR POLYMER BASED PIPEWORK, REFER SPECIFICATION FOR
- ALL PIPEWORK ON DRAWINGS IS SHOWN BELOW SLAB (OR GROUND) UNLESS NOTED OTHERWISE.

DRAWING LIST

TITLE SHEET & LOCALITY PLAN DA-C-002 LEGEND, ABBREVIATIONS & DRAWING LIST GENERAL NOTES DA-C-003 SURVEY PLAN - SHEET 1 DA-C-004 DA-C-005 SURVEY PLAN - SHEET 2 DA-C-006 EROSION AND SEDIMENT CONTROL PLAN - SHEET 1 EROSION AND SEDIMENT CONTROL PLAN - SHEET 2 DA-C-007 EROSION AND SEDIMENT CONTROL DETAILS DA_C_ODS DA-C-101 PUBLIC DOMAIN CIVIL WORKS LEVELS PLAN - SHEET PUBLIC DOMAIN CIVIL WORKS LEVELS PLAN - SHEET 2 DA-C-102 PUBLIC DOMAIN CIVIL WORKS DA-C-103 SITE FRONTAGE CROSS SECTIONS - SHEET 1 DA-C-104 PUBLIC DOMAIN CIVIL WORKS SITE FRONTAGE CROSS SECTIONS - SHEET 2 PUBLIC DOMAIN CIVIL WORKS DRIVEWAY No. 1 PLAN PUBLIC DOMAIN CIVIL WORKS DA-C-112 DRIVEWAY No. 1 LONGITUDINAL SECTION A PUBLIC DOMAIN CIVIL WORKS DRIVEWAY No. 2 PLAN DA-C-113 PUBLIC DOMAIN CIVIL WORKS DRIVEWAY No. 2 LONGITUDINAL SECTION B DA-C-114 DA-C-115 PUBLIC DOMAIN CIVIL WORKS DRIVEWAY No. 3 PLAN PUBLIC DOMAIN CIVIL WORKS DRIVEWAY No. 3 LONGITUDINAL SECTION C DA-C-116 PUBLIC DOMAIN CIVIL WORKS DA-C-117 PUBLIC DOMAIN CIVIL WORKS DA-C-118 DRIVEWAY No. 4 LONGITUDINAL SECTION D PUBLIC DOMAIN CIVIL WORKS DRAINAGE PLAN - SHEET 1 DA-C-301 PUBLIC DOMAIN CIVIL WORKS DA-C-302 DRAINAGE PLAN - SHEET 2 DA-C-321 PUBLIC DOMAIN CIVIL WORKS STORMWATER LONG SECTIONS - SHEET PUBLIC DOMAIN CIVIL WORKS STORMWATER LONG SECTIONS - SHEET 2 DA-C-322 PUBLIC DOMAIN CIVIL WORKS DA-C-323 STORMWATER LONG SECTIONS - SHEET 3 DA-C-324 PUBLIC DOMAIN CIVIL WORKS VATER LONG SECTIONS - SHEET 4 PUBLIC DOMAIN CIVIL WORKS PAVEMENT PLAN - SHEET 1 PUBLIC DOMAIN CIVIL WORKS DA-C-602 PAVEMENT PLAN - SHEET 2 PUBLIC DOMAIN CIVIL WORKS DA-C-603

IMPORTANT NOTES:	REVISION	DATE	DESCRIPTION	BY
Do not scale from drawings. All dimensions shall be checked	A	2016,11,15	PRELIMINARY ISSUE FOR COORDINATION	LP
on alte before commencement of work. All discrepancies	В	2016.11.16	DEVELOPMENT APPLICATION	LP
shall be brought to the attention of the Architect. Larger scale drawings and written dimensions take precedence. This	С	2016,11,17	DEVELOPMENT APPLICATION	LP
drawing is copyright and the property of the author, and must	D	2017.02.03	DEVELOPMENT APPLICATION	LP
not be retained, copied or used without the express authority of MARCHESE PARTNERS ENGINEERING PTY TD				

DEVELOPMENT

APPLICATION

marchesepartners

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DPG PROJECT 7 PTY LTD	LEGEND, A	ABBREVIATIO G LIST	ONS	
PROJECT 14-38 COWPER ST, 21-41 EAST ST,	SCALE NTS@A1 NTS@A3	DATE 10.11.2016	DRAWN TF	CHECKED LP
5-5A ROWELL ST GRANVILLE NSW 2142	ЈОВ 0991	DA-C-002		REVISION D

NOTES

GENERAL

- 1. N/A
- 2. N/A
- 3. ALL DIMENSIONS IN MILLIMETRES UNO. REDUCED LEVELS AND CHAINAGES ARE IN METRES. DO NOT SCALE DRAWINGS. USE FIGURED DIMENSIONS.
- 4. THE PROPOSED WORKS DETAILED HEREIN SHALL BE CONSTRUCTED TO THE REQUIREMENTS OF COUNCIL GENERALLY AS DETAILED HEREUNDER.
- ALL EXISTING SERVICES SHALL BE VERIFIED FOR DEPTH AND HORIZONTAL POSITION BY PHYSICAL MEANS PRIOR TO EXCAVATION. ANY DISCREPANCIES SHALL BE BROUGHT FORTHWITH TO THE PROJECT MANAGER'S ATTENTION.

STORMWATER AND SUBSOIL DRAINAGE

- PIPES AND FITTINGS FOR STORMWATER DRAINAGE SHALL BE AS FOLLOWS UNO ON THE DRAWINGS:
- A. POLYVINYL CHLORIDE (PVC) WITH SOLVENT WELDED JOINTS FOR BELOW GROUND DRAINAGE UP TO 225mm
- B. REINFORCED CONCRETE WITH RUBBER RINGS FOR PIPE DIA'S GREATER THAN 225mm UNO
- C. REINFORCED CONCRETE WHERE REQUIRED BY AS 3500 FOR EXCESSIVE DEPTH.
- D. INSTALL IN ACCORDANCE WITH AUSTRALIAN STANDARD AS:3500 EXCEPT WHERE VARIED BY THE CONTRACT DOCUMENTS.
- 2. PIPES & FITTINGS FOR SUBSOIL DRAINAGE SHALL BE SLOTTED POLYVINYL CHLORIDE (PVC) WITH SOLVENT WELDED JOINTS, MIN. 150mm DIAMETER
- 3. IN GROUND DRAINAGE PIPEWORK SERVING DP's SHALL BE MINIMUM 150mm DIA, UNO
- A. 150mm NOM. WIDTH IN NON TRAFFICABLE AREAS.
- B 225mm NOM WIDTH IN TRAFFICABLE AREAS
- 5. STORMWATER PITS ARE AS SHOWN & SPECIFIED ON THE PLANS . PRECAST TYPE ACCEPTABLE NITH STEP IRONS FOR DEPTH GREATER THAN 1000. BENCH ALL PITS MIN. 50mm & FORM SMOOTH
- SELECT FILL SHALL BE MATERIAL OBTAINED FROM EXCAVATION OF THE PIPE TRENCH OR IMPORTED WITH A PARTICLE SIZE FOR ROCK NOT GREATER THAN 75mm OR FOR OTHER THAN ROCK NOT GREATER THAN 150mm
- IMPORTED FILL SHALL BE EITHER, AND GENERALLY CONSIST OF SINGLE SIZED AGGREGATE WITH PARTICLE SIZE NOT GREATER THAN 5mm WRAPPED ALL ROUND WITH GEOTEXTILE FILTER FABRIC OR APPROVED HIGH COMPACTION SAND OR APPROVED CRUSHED ROAD GRAVEL CONFORMING TO
- STORMWATER PITS AND GRATES TO CONFORM WITH STANDARD COUNCIL REQUIREMENTS, WHERE ON PUBLIC LAND. GRATES TO BE SUPPLIED IN CLASS SHOWN ON THE DRAWINGS.

INSTALLATION REQUIREMENTS:

- PIPES SHALL BE TRUE TO GRADES SHOWN AND ALIGNED SO THAT THE CENTRES OF THE INLET
 PIPES INTERSECT WITH THE CENTRE OF THE OUTLET PIPE AT THE DOWNSTREAM FACE OF THE
 PIT.
- 10. MINIMUM GRADES FOR GRAVITY STORMWATER DRAINAGE SHALL CONFORM TO AS3500 PART3 AS FOLLOWS, UNO:
 - 1% FOR 100 AND 150 mm DIA
- 0.5% FOR 225 mm DIA 0.35% FOR 375 mm DIA

DEVELOPMENT

- 11. MINIMUM DEPTH OF COVER SHALL BE :- 300mm IN PRIVATE PROPERTY (NON VEHICULAR TRAFFIC).
 - 450mm IN PUBLIC AREAS.
 600mm IN VEHICULAR TRAFFICABLE AREAS (FOOTWAY/ROADWAY).
- 12. BED ALL PIPES FIRMLY AND EVENLY ONTO IMPORTED BEDDING FILL MATERIAL.
- LAY AND JOINT ALL PIPES IN ACCORDANCE WITH THE MANUFACTURERS RECOMMENDATIONS AND: AS 3725-1989 LOADS ON BURIED CONCRETE PIPES AS 2566-1998 BURIED FLEXIBLE PIPELINES
- AS 1597.2-1996 PRECAST REINFORCED CONCRETE BOX CULVERTS
- AS 3500-1990 NATIONAL PLUMBING & DRAINAGE CODE PART 2, SANITARY PLUMBING AND SANITARY DRAINAGE.
- SYDNEY WATER REQUIREMENTS.
- 14. ALLOW TO TEST ALL PIPES AND PITS TO MANUFACTURERS REQUIREMENTS

CONCRETE WORKS

- ALL WORKMANSHIP AND MATERIALS SHALL BE IN ACCORDANCE WITH AS3600, THE STANDARDS
 ASSOCIATION AUSTRALIA, STANDARDS CITED IN AS3600, THE DRAWINGS AND THE SPECIFICATION
- ALL CONCRETE SHALL BE 80mm NOMINAL SLUMP, 20mm MAXIMUM AGGREGATE WITH NO ADMIXTURES OR FLY ASH, UNLESS OTHERWISE APPROVED.
 - ALL CONCRETE WORK IN CONTACT WITH SEWER TO HAVE TYPE SL PORTLAND CEMENT. OTHERWISE TYPE A CEMENT.
 - FOR BRIDGE WORKS, A MAXIMUM 56 DAYS SHRINKAGE OF 600 MICROSTRAIN, A MINIMUM CEMENT CONTENT 350kg/m3 AND MAXIMUM WATER: CEMENT RATIO OF 0.40
- 3. STRENGTH GRADE OF CONCRETE SHALL BE:
 - 25 MPa (KERBS, EDGE STRIPS & CONCRETE ENCASEMENT) AND 32 MPa ELSEWHERE
- 4 CONSTRUCTION JOINTS SHALL BE PROPERLY FORMED AND USED ONLY WHERE SHOWN OF CONSTRUCTION JOINTS SHALL BE PROPERLY FORMED AND USED ONLY WHERE SHOWN OR APPROVED, DEMPALLY FOR HAND PLACED KERS & QUITTER 6mm THICK APPROVED BITWINDUS APPROVED BITWINDUS APPROVED BITWINDUS APPROVED BITWINDUS APPROVED BITWINDUS MASTIC. JOINTING MACHINE PLACED KERS & QUITTER 6mm THICK APPROVED BITWINDUS MASTIC. JOINTING MATERIAL, SHALL BE PROVIDED AT NITERVIALS NOT EXCEEDING 12m & QUILLOTINED DUMMY GROOVED JOINTS, Z6mm IN DEPTH, SHALL BE FORMED EVERY 9m OF GUITTER. JOINTS ARE ALSO REQUIRED AT EACH END OF GUITTER. JOINTS ARE ALSO CALLED AND AND AND SHALL BE STEVERTICAL. AND SQUARE TO THE KERB.
- 5. REINFORCEMENT IS REPRESENTED DIAGRAMMATICALLY AND IS NOT NECESSARILY SHOWN IN
- WELDING OR SPLICES IN REINFORCEMENT SHALL BE USED ONLY IN POSITIONS APPROVED BY THE ENGINEER.
- 7. CONCRETE CURING SHALL BE IN ACCORDANCE WITH AS3600, CURING SHALL BE COMMENCED WITHIN TWO HOURS OF FINISHING OPERATIONS AND SHALL BE CONTINUED FOR A MINIMUM OF SEVEN DAYS BY AN APPROVED PROPRIETARY COMPOUND OR BY KEEPING CONTINUOUSLY WET
- FORMWORK SHALL BE DESIGNED AND CONSTRUCTED IN ACCORDANCE WITH AS3610, FORMWORK SHALL NOT BE STRIPPED NOR PROPS REMOVED WITHOUT APPROVAL.
- 9. FABRIC LAP DETAILS SHALL BE IN ACCORDANCE WITH FIG.13.2.4 OFAS3600.
- 10. HOOKS, LAPS AND BENDS SHALL BE IN ACCORDANCE WITH AS3600 UNO.
- 11 ALL CHEMICAL ANCHORS SHALL BE EITHER 'CHEMSET' BY "RAMSET" WITH THE GLASS CAPSULE SYSTEM INSTALLED IN STRICT ACCORDANCE WITH MANUFACTURERS INSTRUCTIONS
- OR HILTI HVU ADHESIVE ANCHOR WITH FOIL CAPSULE SYSTEM INSTALLED IN STRICT ACCORDANCE WITH MANUFACTURERS INSTRUCTION, ALL CHEMICAL ANCHORS SHALL BE HOT DIPPED GALVANIZED AND BE MIN M16 DIA. U.N.O.

GENERAL EARTHWORKS, SITEWORKS & FILLING:

- 2. THE RECOMMENDATIONS CONTAINED IN THE GEOTECH REPORT SHALL OVERRIDE THE CLAUSES PRESENTED HEREIN.
- 3. STRIP ALL TOPSOIL AND UNDERLYING FILL AND STOCKPILE TOPSOIL FOR LATER REUSE FOR
- NEW FILL REQUIRED TO REINSTATE CUT LEVELS TO PROPOSED BENCHING LEVELS SHALL BE SOURCED FROM OTHER PARTS OF THE EXCAVATION AS SELECT FILL OR IMPORTED FILL AS SPECIFIED BELOW IN NOTES 5 AND 6.
- 5. SELECT FILL SHALL CONSIST OF LOCALLY DERIVED OR CUT NATURAL CLAYS.
- 6. IMPORTED FILL SHALL CONSIST OF RIPPED SANDSTONE OR SHALE OR SIMILAR MATERIAL WITH MAXIMUM PARTICLE SIZE NOT GREATER THAN 120mm AND A MOISTURE CONTENT WITHIN 2-3% OF STANDARD OPTIMUM.
- 7. ALL FILL (COHESIVE SOIL) SHALL BE PLACED IN LAYERS OF 200mm MAXIMUM THICKNESS COMPACTED BY MACHINE ROLLING TO ACHIEVE A DRY DENSITY RATIO OF NOT LESS THAN 98% STANDARD MAXIMUM AT A CORRESPONDING MOISTURE CONTENT WITHIN 2-3% OF STANDARD
- 8. IN AREAS WHERE HIGH IMPACT ROLLING IS USED TEST EACH FINAL LAYER OF NOT GREATER THAN 300mm TO 400mm TO 400mm

- 9 ALL TEMPORARY BATTERS CUT IN CLAY SUBSTRATE SHALL BE 1 HORIZ: 1 VERT ALL LING TERM EXPOSED BATTERS CUT IN CLAY SUBSTRATE SHALL BE 2 HORIZ: 1 VERT. ALL DETENTION BASIN BATTERS IN ROLAY SUBSTRATE SHALL BE 3 HORIZ: 1 VERT. ALL DETENTION BASIN BATTERS IN ROLAY SUBSTRATE SHALL BE NEAR VERTICAL.
- GEOTECHNICAL TESTING IS TO BE UNDERTAKEN TO AT LEAST LEVEL 1 CONTROL OF FILL COMPACTION STANDARD, AS DEFINED IN AS. 3738 AS FOLLOWS:
 - FOR GENERAL FILL OR CUT AREAS OVER THE AREA PROVIDE ONE (1) TEST PER 200mm LAYER,
 - FOR GENERAL FILL AREAS IN CONCENTRATED AREAS ADJACENT TO AND BEHIND THE STRUCTURE AND ADJACENT TO AND BEHIND RETAINING WALLS PROVIDE ONE (1) TEST PER 200mm LAYER, OVER AN AREA NOT GREATER THAN 50m².
- 11. SUBMIT ALL GEOTECHNICAL TEST RESULTS TO LP CONSULTING AUSTRALIA FOR REVIEW PRIOR TO CONTINUATION WITH SUBSEQUENT SECTION OF WORK

Kuala Lumpur · Auckland

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EARTHWORKS FOR SERVICES

- EXCAVATE TRENCHES AND STOCKPILE ALL MATERIAL FOR INSPECTION WITH REGARD TO RE-USE FOR TRENCH BACKFILL. REMAINING MATERIAL TO BE REMOVED FROM SITE.
- BEDDING MATERIAL SHALL CONSIST OF IMPORTED FILL ONLY. THICKNESS OF BEDDING LAYER SHALL BE 75mm IN O.T.R. AND 200mm IN ROCK.
- 3 EMBED ALL PIPES WITH IMPORTED FILL PROVIDE 200mm SIDE SUPPORT AND 150mm OVERLAY
- TRENCH FILL ABOVE THE EMBEDMENT ZONE TO THE UNDERSIDE OF THE ROAD PAVEMENT OR FOOTWAY FILL MATERIAL SHALL BE AS FOLLOWS:

TRENCH FILL MATERIAL SHALL CONSIST OF IMPORTED FILL AS SPECIFIED HEREIN OF EITHER HIGH GRADE COMPACTION SAND OR APPROVED CRUSHED ROAD GRAVEL CONFORMING TO RTA FORM 3051 OR SIMILAR.

OTHER THAN ROADWAY

TRENCH FILL MATERIAL EXCAVATED SHALL CONSIST OF SELECT FILL AS SPECIFIED HEREIN AND SHALL NOT CONTAIN MORE THAN 20% OF STONES OF SIZE BETWEEN 75mm & 150mm AND NONE LARGER THAN 150mm, PRIOR TO THE USE OF THE EXCAVATED MATERIAL IT SHALL BE INSPECTED AND APPROVED BY THE CONSULTANT

5. COMPACT BEDDING, EMBEDMENT AND TRENCH FILL MATERIALS AS FOLLOWS:

FOR GRANULAR FILL MATERIAL (NON-COHESIVE SOILS) EG. COARSE AGGREGATE FILL, HIGH GRADE COMPACTION SAND, THE DENSITY INDEX (ID) SHALL BE NOT LESS THAN 70%.

FOR GRANULAR MATERIAL (NON-COHESIVE SOILS), THE DENSITY INDEX (ID) SHALL BE NOT LESS

FOR NON-GRANULAR FILL MATERIAL (COHESIVE SOILS), THE DRY DENSITY RATIO (RD) SHALL BE NOT LESS THAN 95%.

6. MEASURE OF COMPACTION:-

THE DEGREE OF COMPACTION SHALL BE MEASURED BY ONE OF THE FOLLOWING PARAMETERS :-

GRANULAR FILL (NON-COHESIVE SOILS). THE DENSITY INDEX (ID) DETERMINED IN ACCORDANCE SPANULAR FILE (NON-CORDANIES SOLS). THE DENSITY INDEX (ID) DETERMINED IN ACCORDANCE WITH AS 1289-E6.1 BASED ON THE MAXIMUM AND MINIMUM DRY DENSITIES IN ACCORDANCE WITH AS 1289-E3.2, AS 1289-E3.5 OR

NON-GRANULAR FILL (COHESIVE SOILS). THE DRY DENSITY RATION (RD) DETERMINED IN ACCORDANCE WITH AS 1289.5.4.1 BASED ON THE FIELD DRY DENSITY IN ACCORDANCE WITH AS 1289.5.3.2 AND THE MAXIMUM DRY DENSITY IN ACCORDANCE WITH AS 1289.5.1.1.

GEOTECHNICAL TESTING IS TO BE UNDERTAKEN TO AT LEAST LEVEL 1 CONTROL OF FILL COMPACTION STANDARD, AS DEFINED IN AS. 3738 AS FOLLOWS:

TEST EACH 300mm LAYER ABOVE PIPE CROWN.

TEST BASE & SUB-BASE LAYERS WHERE APPLICABLE.

TESTS SHALL BE REQUIRED AT EACH 50m CENTRES WHERE THE LENGTH OF TRENCH IS WITHIN

SUBMIT ALL GEOTECHNICAL TEST RESULTS TO LP CONSULTING AUSTRALIA FOR REVIEW PRIOR TO CONTINUATION WITH SUBSEQUENT SECTION OF WORK.

RESTORATION

- 1. RESTORE ALL TRAFFIC AREAS TO PRE EXISTING CONDITION.
- FOR ALL SURFACES OTHER THAN IN TRAFFIC AREAS RESTORE DISTURBED SURFACES TO PRE-EXISTING CONDITIONS AND COMPACT AS SPECIFIED.
- 3. RESTORE ALL AUTHORITY OWNED AREAS TO COUNCIL STANDARDS

- 1. THE AS CONSTRUCTED WORKS SHALL BE INSPECTED BY DESIGN CONSULTANT. MINIMUM 48 HOURS NOTICE SHALL APPLY TO ALL INSPECTIONS.
- THE DESIGN PLANS HEREIN ARE SUBJECT TO COUNCIL APPROVAL PRIOR TO CONSTRUCTION.
 OBTAIN EXPRESS (WRITTEN) ADVICE TO PROCEED FROM PROJECT MANAGER PRIOR TO
- 3. SUBMIT WORK-AS-EXECUTED DRAWINGS IN CIVILCAD OR DXF DIGITAL FORMAT AND HARD COPY FORMAT. VERIFY ALL CONSTRUCTION WORKS SHOWN HEREON
- CERTIFY THAT THE AS CONSTRUCTED SYSTEM HAS BEEN BUILT IN ACCORDANCE WITH THE APPROVED PLANS ISSUED FOR CONSTRUCTION.

SERVICES UNDER ROAD SURFACES

ALL OTHER SERVICES INCLUDING BUT NOT LIMITED TO WATER, HYDRANT, GAS, SEWER, ELECTRICAL AND COMMUNICATIONS CONDUITS OR CABLES SHALL BE LAID WITH MINIMUM 600mm

COVER BELOW PROPOSED ROAD SURFACE OR APPROVED OTHER MEANS TO PROTECT DURING

HYDRAULIC SERVICES

- 1. ALL WORKS CARRIED OUT SHALL COMPLY WITH AS-3500, SYDNEY WATER & COUNCIL REQUIREMENTS. OBTAIN NECESSARY AUTHORITIES APPROVALS PRIOR TO COMMENCING WORKS.
- 2. PRIOR TO COMMENCING WORKS SURVEY & INSPECT SITE & CONFIRM LOCATION & LEVELS OF ALL PRIOR TO COMMENCING WURKLS SURVE, A MANUAL PROPERTY OF THE MODELLO SERVICES PREMORED NO CLAIMS FOR ADDITIONAL COSTS RESULTING FROM THE LACK OF KNOWLEDGE OF SITE CONDITIONS RELATING TO WORKS TO BE DONE OR LOCATIONS AND LEVELS OF EXISTING AND
- 3. PRIOR TO CAPPING OFF & REMOVAL OF REDUNDANT SERVICES CONFIRM ON SITE THAT SERVICE IS NOT SUPPLYING EXISTING BUILDINGS OR AMENITIES.
- 4. COLD WATER PIPEWORK SHALL CONSIST OF COPPER TUBE & FITTINGS IN ACCORDANCE WITH AS 1432 TYPE B. PIPES AND FITTINGS SHALL BE JOINTED WITH 15% SILVER SOLDER
- ALL NEW UNDERGROUND METAL PIPEWORK SHALL BE INSTALLED WITH POLYETHYLENE SLEEVING OBTAINED FROM "TYCO WATER AUST" AND INSTALLED TO MANUFACTURE'S REQUIREMENTS.
- 6. LANDSCAPE IRRIGATION WATERING PIPEWORK SHALL CONSIST OF MEDIUM DENSITY POLYETHYLENE PIPE CLASS PN16 WITH ELECTRO FUSION JOINTS OR EQUAL TO EXISTING

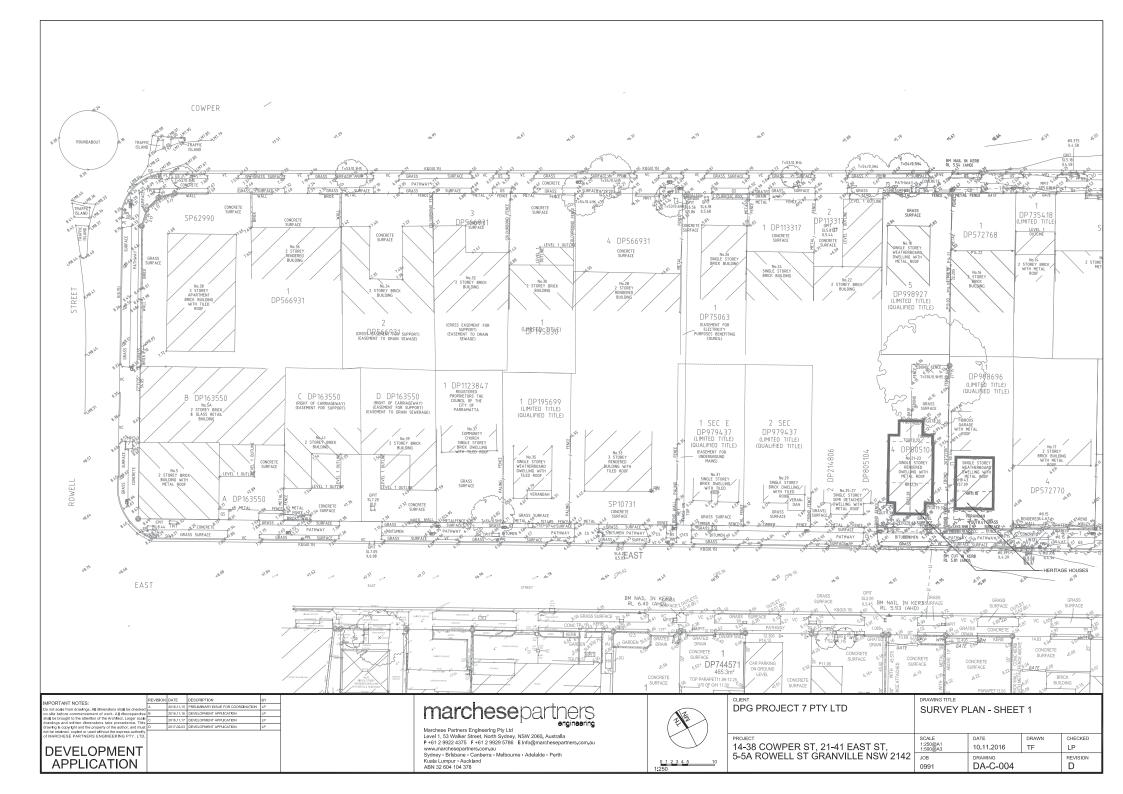
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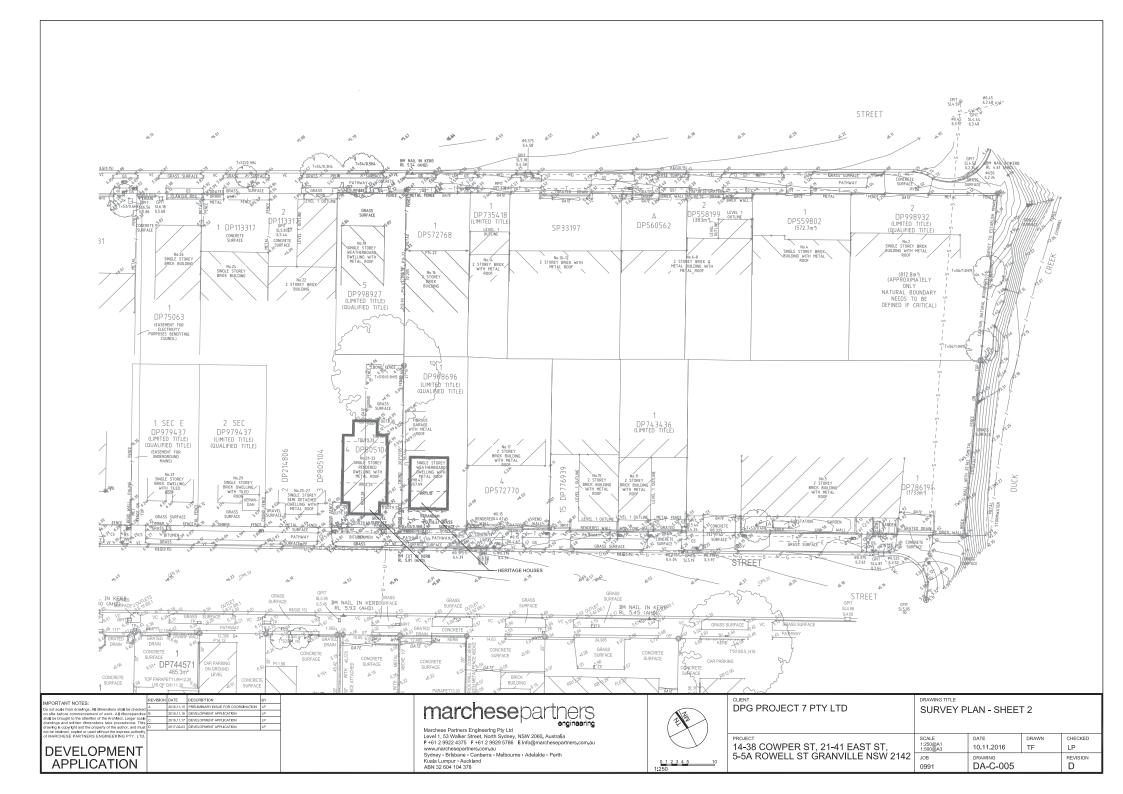
marchesepartners

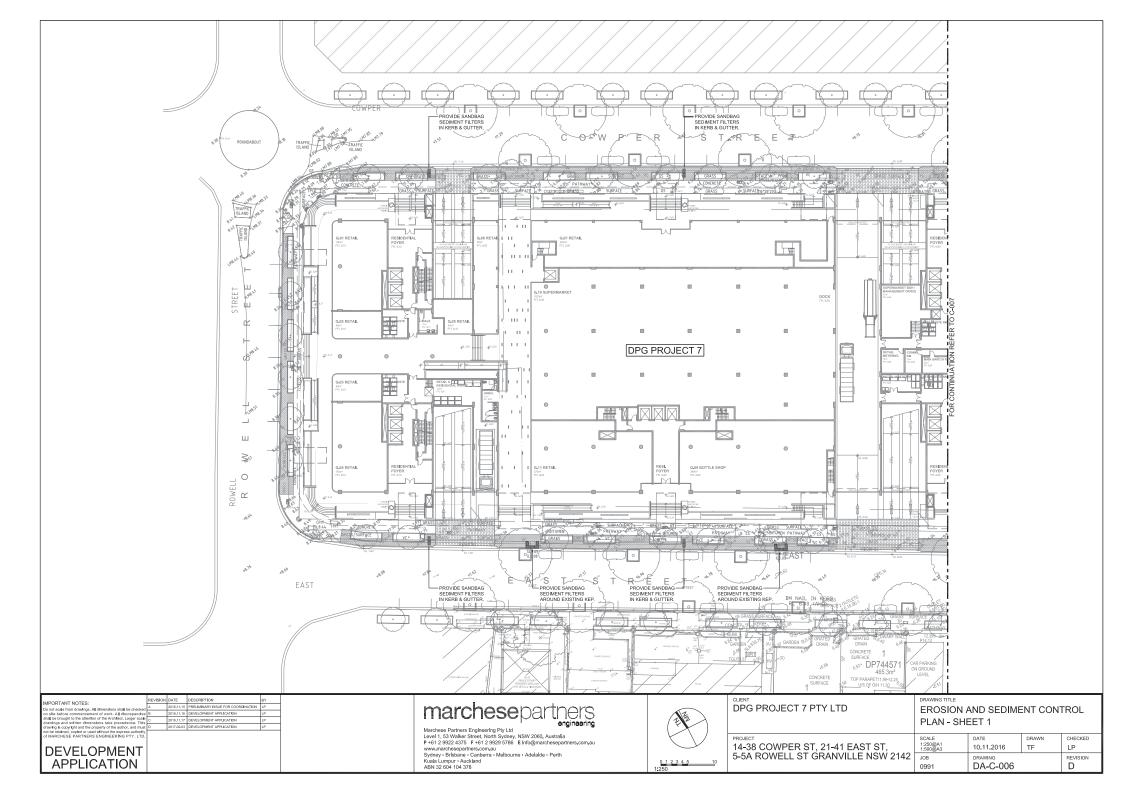
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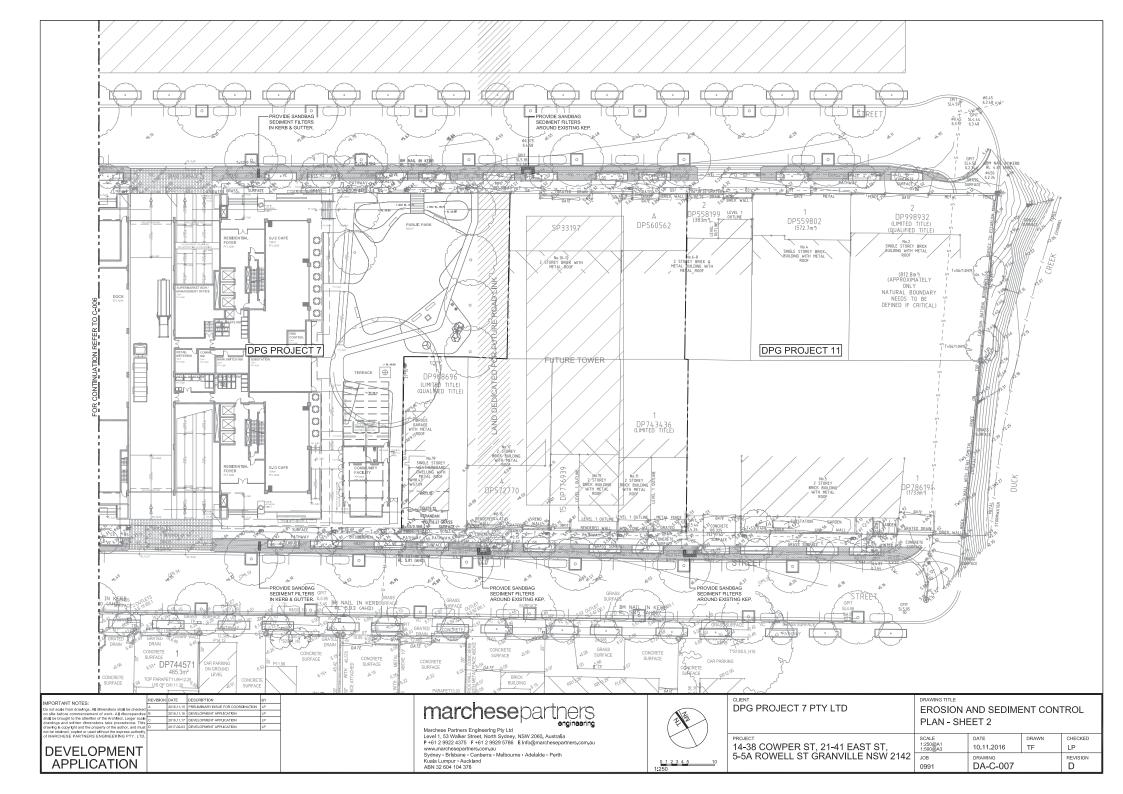
Marchese Partners Engineering Pty Ltd Level 1, 53 Walker Street, North Sydney, NSW 2060. Australia P+61 2 9922 4375 F+61 2 9929 5786 E Info@marchesepartners.com.au Sydney · Brisbane · Canberra · Melbourne · Adelaide · Perth

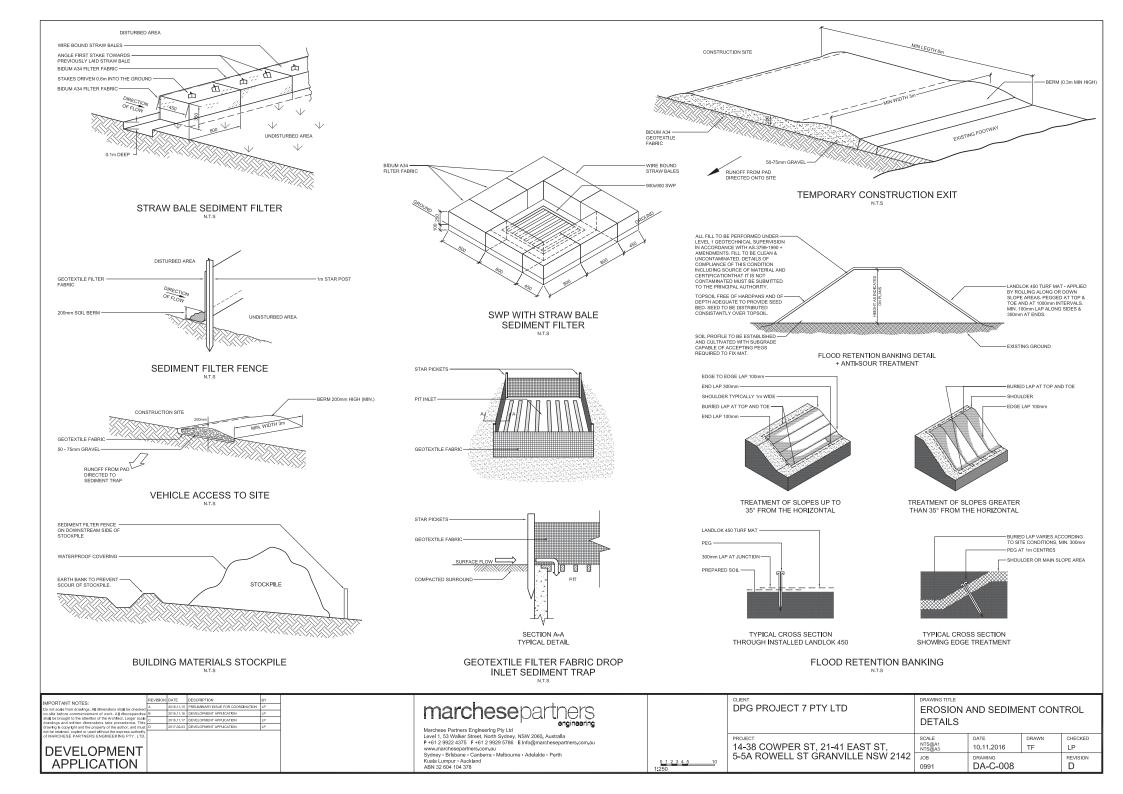
DRAWING TITLE DPG PROJECT 7 PTY LTD **GENERAL NOTES** SCALE NTS@A1 NTS@A3 CHECKED 14-38 COWPER ST. 21-41 EAST ST. 10.11.2016 TF 5-5A ROWELL ST GRANVILLE NSW 2142 JOB DRAWING REVISION DA-C-003 D 0991

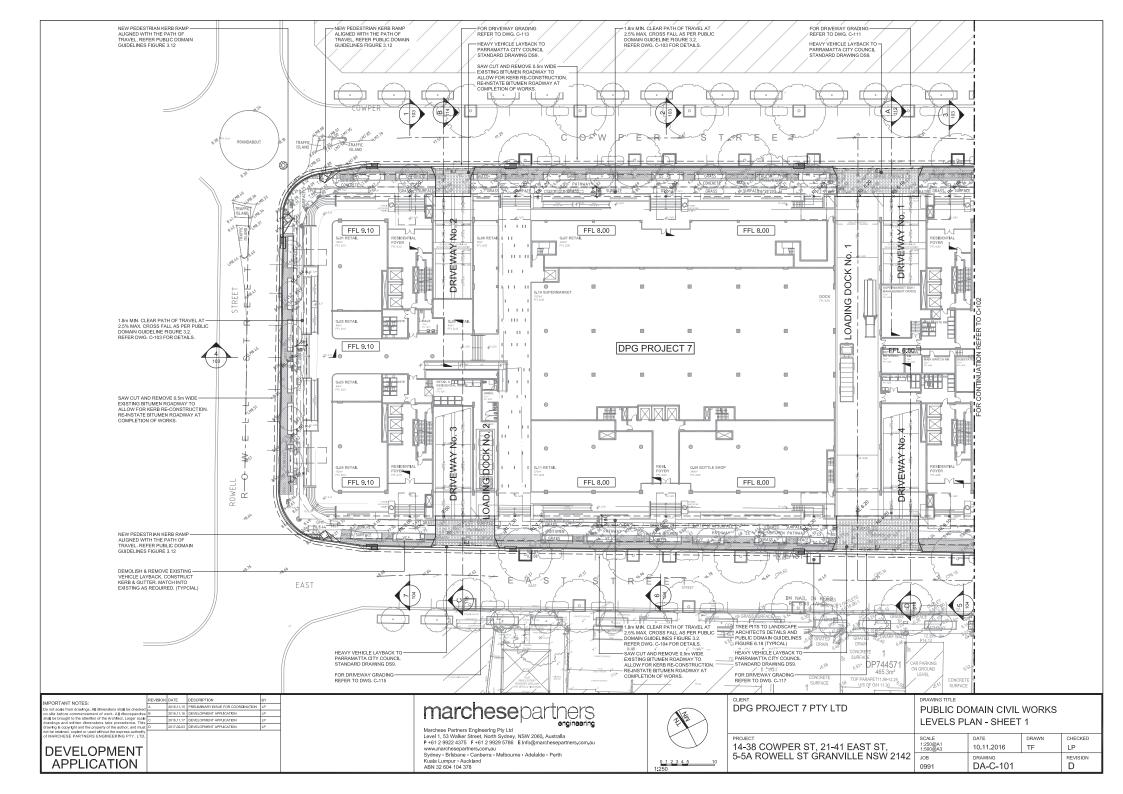


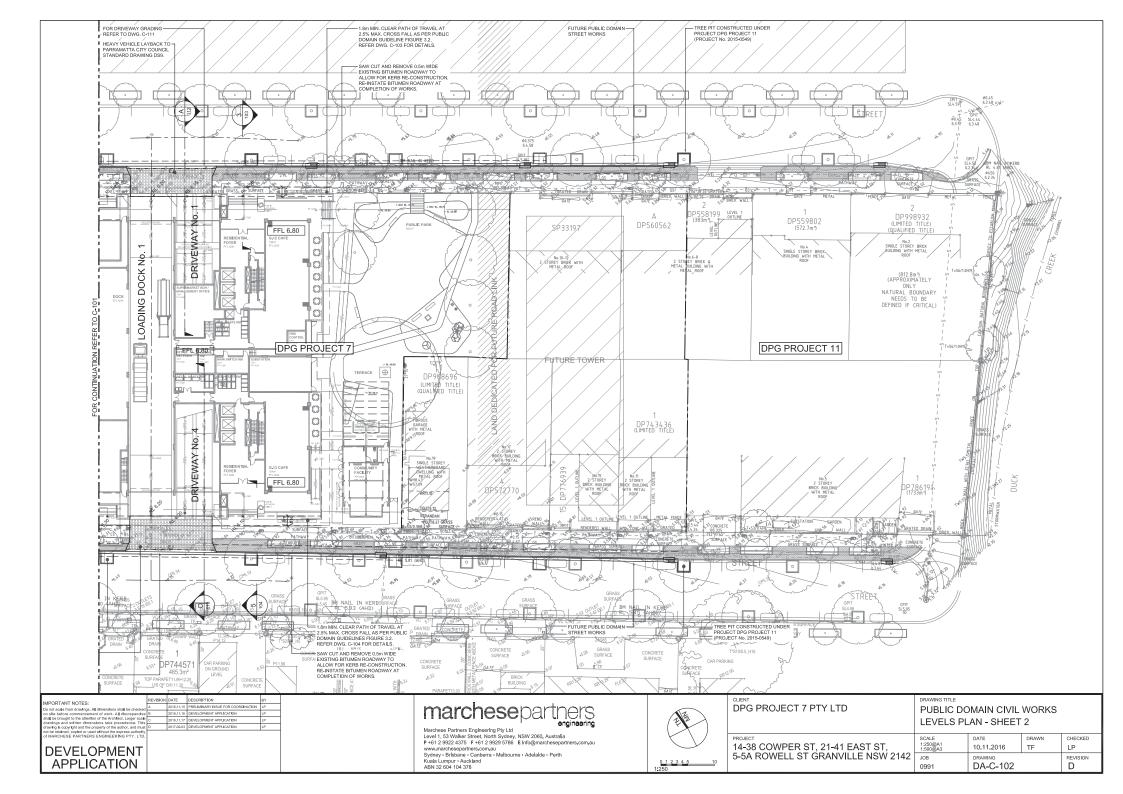


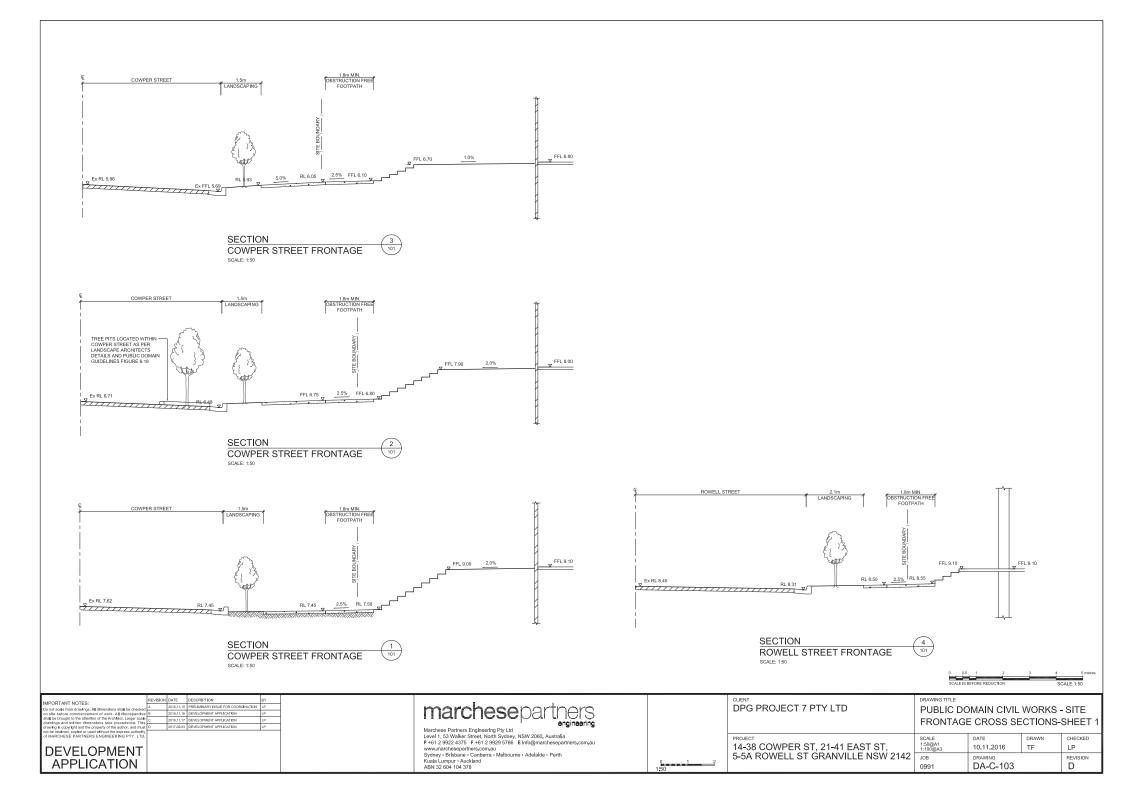


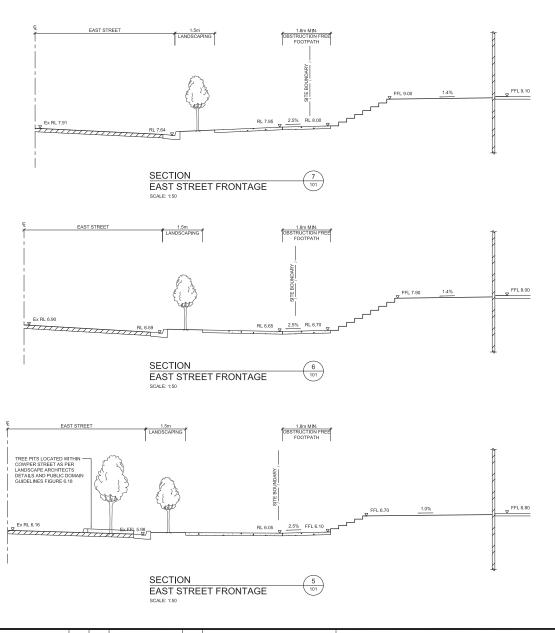






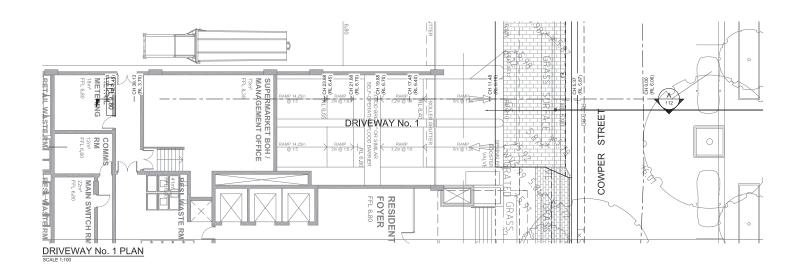






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DEVELOPMENT APPLICATION					Level 1, 53 Walker Street, North Sydney, NSW 2060, Australia P+61 29924375 F+61 2995 9768 E Info@marchespartners.com.au www.marchesepartners.com.au Sydney- Efblaane - Canberra - Melbourne - Adelalde - Perth Kuala Lumpur - Auckland ABN 32 604 104 378	0 1 2 1:50	PROJECT 14-38 COWPER ST, 21-41 EAST ST, 5-5A ROWELL ST GRANVILLE NSW 2142		DATE 10.11.2016 DRAWING DA-C-104	DRAWN TF	CHECKED LP REVISION D

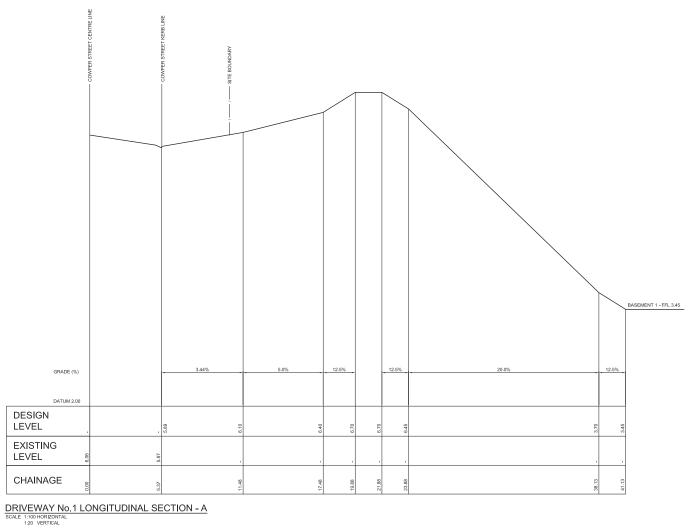


IMPORTANT NOTES:	REVISION	DATE	DESCRIPTION	BY	Г
Do not scale from drawings. All dimensions shall be checked	A	2016.11.15	PRELIMINARY ISSUE FOR COORDINATION	LP	1
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not be retained, copied or used without the express authority of MARCHESE PARTNERS ENGINEERING PTY, LTD.					
DEVELOPMENT APPLICATION					

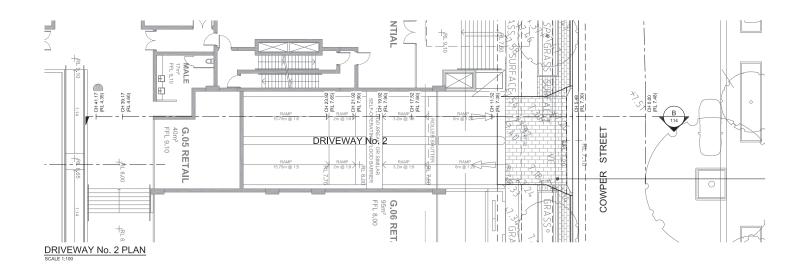
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Level 1, 53 Walker Street, North Sydney, NSW 2000, Australia
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www.marchesepartners.com.au
yokhey - Bribaine - Canberra - Melbourne - Adelalds - Perth
Kuala Lumpur - Auckland
ABN 32 064 104 378



	DPG PROJECT 7 PTY LTD		MAIN CIVIL ' No. 1 PLAN		
	PROJECT 14-38 COWPER ST, 21-41 EAST ST,	SCALE 1:100@A1 1:200@A3	DATE 10.11.2016	DRAWN TF	CHECKED
5	5-5A ROWELL ST GRANVILLE NSW 2142	ЈОВ 0991	DA-C-111		REVISION D



IMPORTANT NOTES: Do not scale from drawings. A detendance shall be obesize on able before commencement of work. All discrepanded to the before commencement of work. All discrepanded considerations and written dimensions take precedence. The drawings and written dimensions take precedence. The drawing is copyright and the property of the author, and must not be related, copied or used without the express authority	A 2016.11.1 B 2016.11.1 C 2016.11.1 D 2017.02.0	DESCRIPTION 5 PRELIMINARY ISSUE FOR 6 6 DEVELOPMENT APPLICATI 7 DEVELOPMENT APPLICATI 3 DEVELOPMENT APPLICATI	N LP	marchese partners Marchese Partners Engineering Pty Ltd		DPG PROJECT 7 PTY LTD		MAIN CIVIL ' No. 1 LONG		N A
of MARCHESE PARTNERS ENGINEERING PTY. LTD				Level 1, 53 Walker Street, North Sydney, NSW 2060. Australia P +61 2 9922 4375 F +61 2 9929 5786 E Info@marchesepartners.com.au		PROJECT	SCALE	DATE	DRAWN	CHECKED
DEVELOPMENT				www.marchesepartners.com.au		14-38 COWPER ST, 21-41 EAST ST,	AS SHOWN @ A1	10.11.2016	TF	LP
				Sydney Brisbane Canberra Melbourne Adelaide Perth Kuala Lumpur Auckland	0 1 2 3 4 5	5-5A ROWELL ST GRANVILLE NSW 2142	JOB	DRAWING		REVISION
APPLICATION				ABN 32 604 104 378	1:100		0991	DA-C-112		D

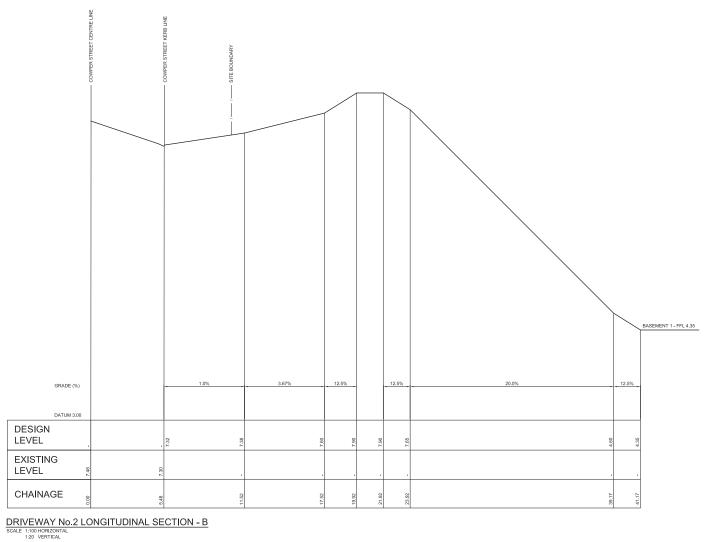


IMPORTANT NOTES:	REVISION	DATE	DESCRIPTION	BY	Γ
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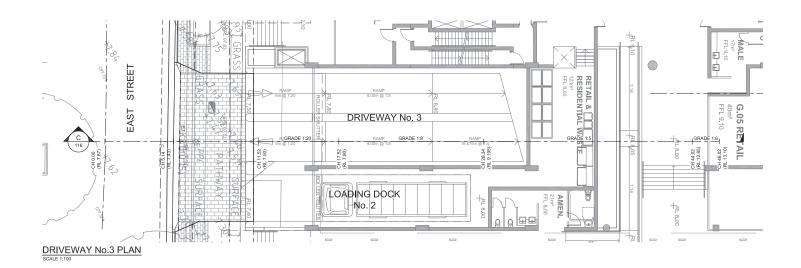
Marchese Partners Engineering Ply Ltd
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www.marchesepartners.com.au
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Abh 32 604 164 579



	DPG PROJECT 7 PTY LTD	PUBLIC DOMAIN CIVIL WORKS DRIVEWAY No. 2 PLAN					
	PROJECT 14-38 COWPER ST, 21-41 EAST ST,	SCALE 1:100@A1 1:200@A3	DATE 10.11.2016	DRAWN TF	CHECKED LP		
5	5-5A ROWELL ST GRANVILLE NSW 2142	ЈОВ 0991	DA-C-113		REVISION D		



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DEVELOPMENT					P +61 2 9922 4375 F +61 2 9929 5786 E Info@marchesepartners.com.au www.marchesepartners.com.au		14-38 COWPER ST, 21-41 EAST ST,	AS SHOWN @ A1	10.11.2016	TF	LP
					Sydney · Brisbane · Canberra · Melbourne · Adelaide · Perth Kuala Lumpur · Auckland		5-5A ROWELL ST GRANVILLE NSW 2142	JOB	DRAWING		REVISION
APPLICATION					ABN 32 604 104 378	1100		0991	DA-C-114		D



IMPORTANT NOTES:	REVISION	DATE	DESCRIPTION	BY	Г
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not be retained, copied or used without the express authority of MARCHESE PARTNERS ENGINEERING PTY, LTD.					
DEVELOPMENT APPLICATION					

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www.marchesepartners.com.au
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Kuala Lumpur - Auckland
ABN 32 064 104 378

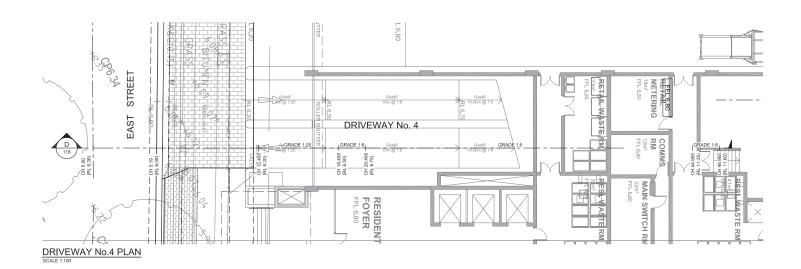


	DPG PROJECT 7 PTY LTD		MAIN CIVIL ' No. 3 PLAN		
	PROJECT 14-38 COWPER ST, 21-41 EAST ST,	SCALE 1:100@A1 1:200@A3	DATE 10.11.2016	DRAWN TF	CHECKED LP
5	5-5A ROWELL ST GRANVILLE NSW 2142	ЈОВ 0991	DA-C-115		REVISION D

LEVEL 1 - FFL 13.10 GRADE (%) DATUM 6.00 DESIGN LEVEL **EXISTING** LEVEL CHAINAGE DRIVEWAY No.3 LONGITUDINAL SECTION - C
SCALE 1:100 HORIZONTAL
1:20 VERTICAL

marchese partners DRAWING TITLE IMPORTANT NOTES:

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Level 1, 53 Walker Street, North Sydney, NSW 2000, Australia
P+612 2962 4375 F +611 2982 9758 E Info@marchesepartners.com.au
www.marchesepartners.com.au
Sydney - Bribaine - Carberra - Melbourne - Adelaide - Perth
Kuala Lumpur - Auckland
ABN 32 064 104 378 SCALE 14-38 COWPER ST, 21-41 EAST ST, 5-5A ROWELL ST GRANVILLE NSW 2142 10.11.2016 TF LP **DEVELOPMENT** JOB DRAWING REVISION APPLICATION 0991 DA-C-116 D



IMPORTANT NOTES:	REVISION	DATE	DESCRIPTION	BY	Γ
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DEVELOPMENT APPLICATION					

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Sydney - Bribaine - Canberra - Melbourne - Adelalds - Perth
Kuala Lumpur - Auckland
ABN 32 040 140 378

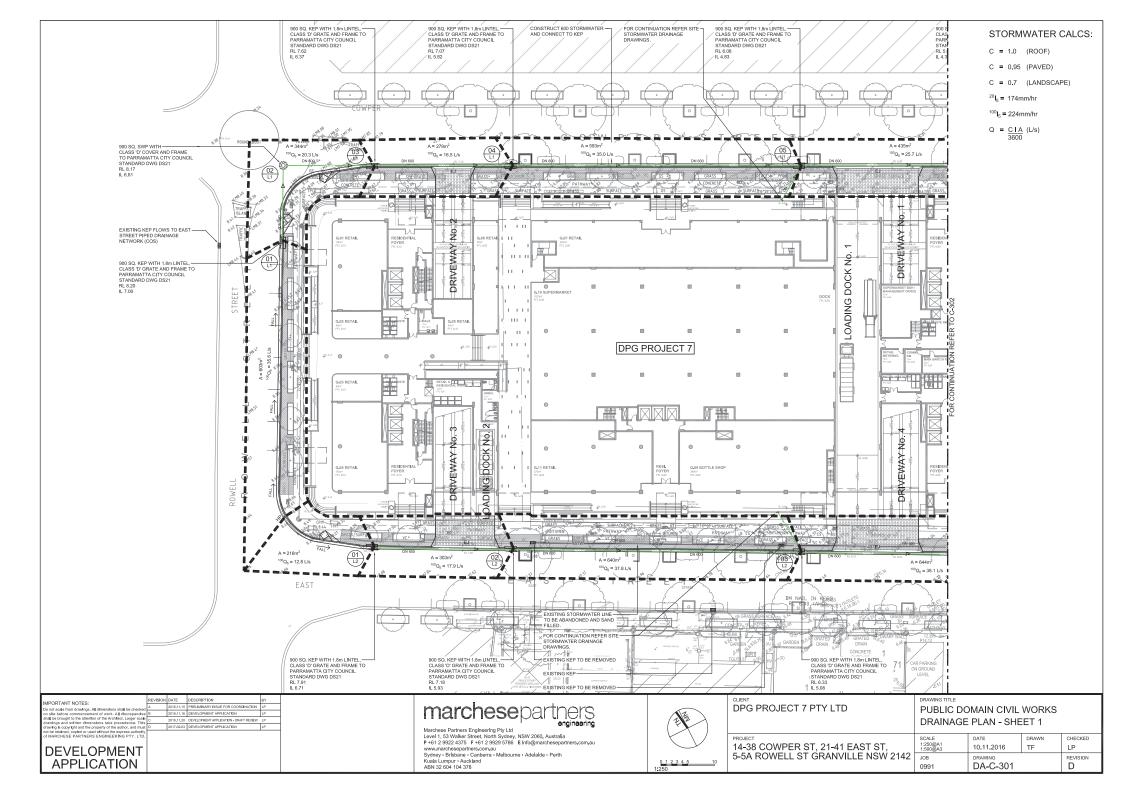


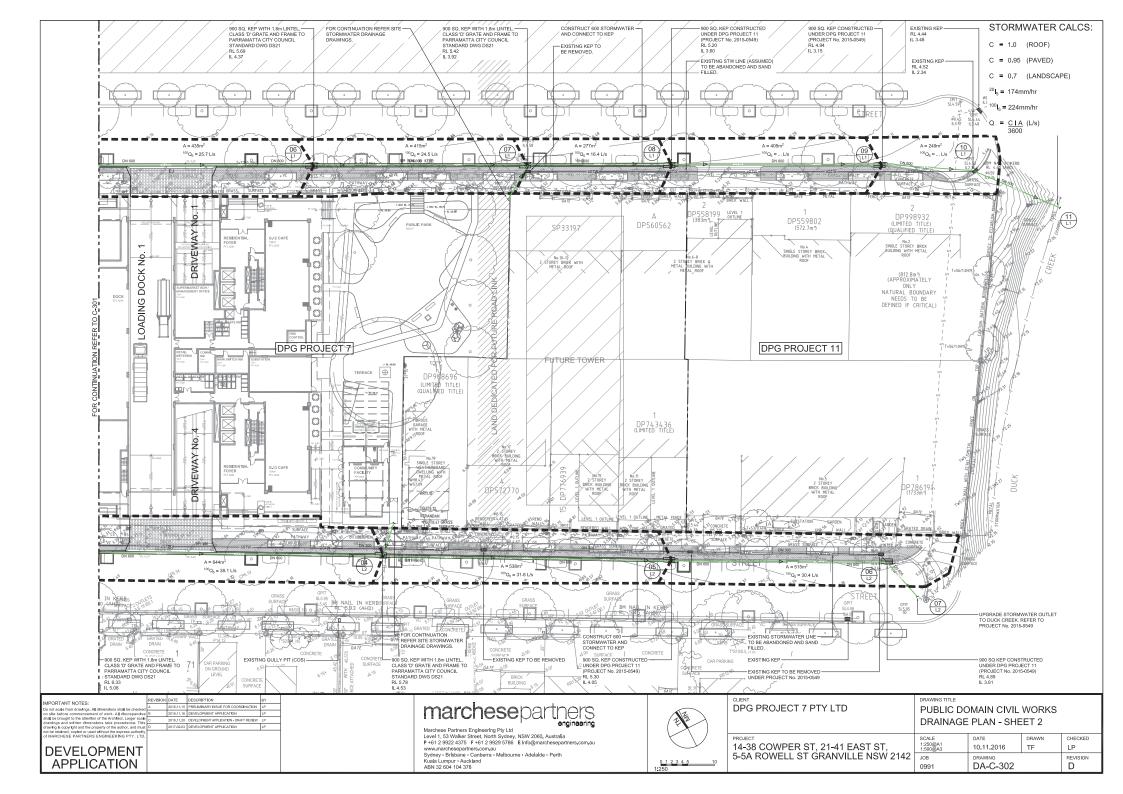
	DPG PROJECT 7 PTY LTD		MAIN CIVIL ' No. 4 PLAN		
	PROJECT 14-38 COWPER ST, 21-41 EAST ST,	SCALE 1:100@A1 1:200@A3	DATE 10.11.2016	DRAWN TF	CHECKED LP
5	5-5A ROWELL ST GRANVILLE NSW 2142	ЈОВ 0991	DA-C-117		REVISION D

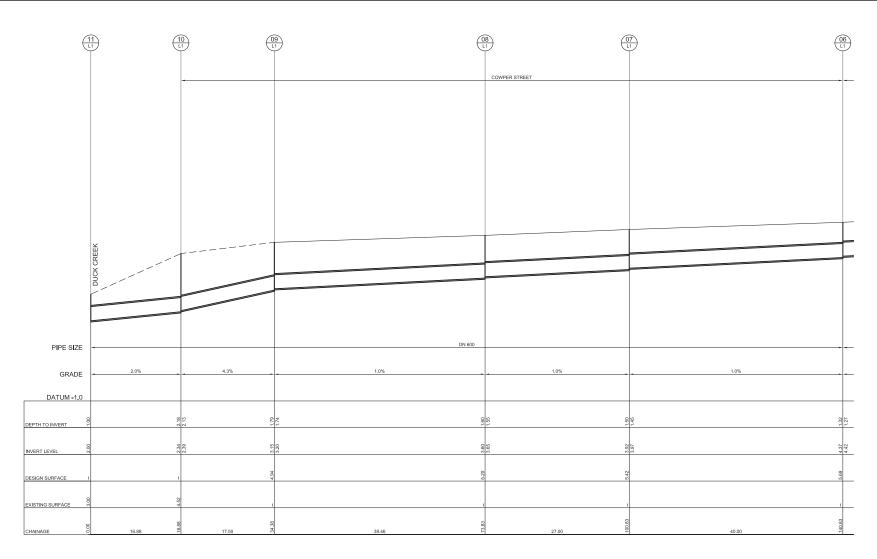
LEVEL 1 - FFL 11.60 GRADE (%) DATUM 5.00 DESIGN LEVEL **EXISTING** LEVEL CHAINAGE DRIVEWAY No.4 LONGITUDINAL SECTION - D

SCALE 1:100 HORIZONTAL
1:20 VERTICAL

IMPORTANT NOTES: Do not scale from drawfigs. All dhrenshins shall be checked on all a before commencement of work. All discrepanded of the commencement of work. All discrepanded drawfigs and witten dimensions take precedence. The drawfig is copyright and the property of the author, and me, no be relatend, copied or used without the sepress authorit	B C	2016.11.15 2016.11.16 2016.11.17	DESCRIPTION PRELIMINARY ISSUE FOR COORDINATION DEVELOPMENT APPLICATION DEVELOPMENT APPLICATION DEVELOPMENT APPLICATION	BY LP LP LP	marchese partners engineering Pty Ltd			PUBLIC DO DRIVEWAY			N D
DEVELOPMENT					Level 1, 53 Walker Street, North Sydney, NSW 2060, Australia P +61 2 9922 4375 F +61 2 9929 5786 E Info@marchesepartners.com.au www.marchesepartners.com.au		PROJECT 14-38 COWPER ST, 21-41 EAST ST,	SCALE AS SHOWN @ A1	DATE 10.11.2016	DRAWN TF	CHECKED LP
APPLICATION					Sydney - Brisbane - Canberra - Melbourne - Adelalde - Perth Kuala Lumpur - Auckland ABN 32 604 104 378	0 1 2 3 4 5	5-5A ROWELL ST GRANVILLE NSW 2142		DA-C-118		REVISION D

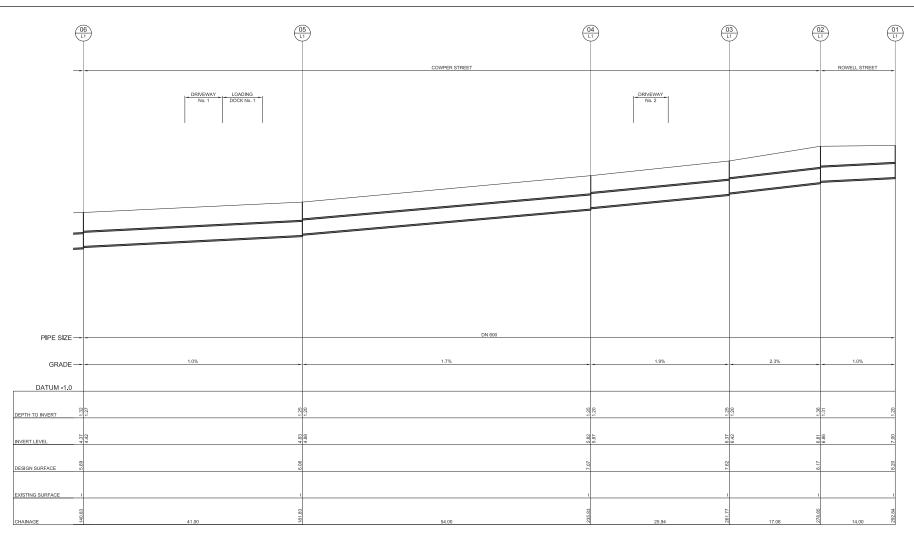




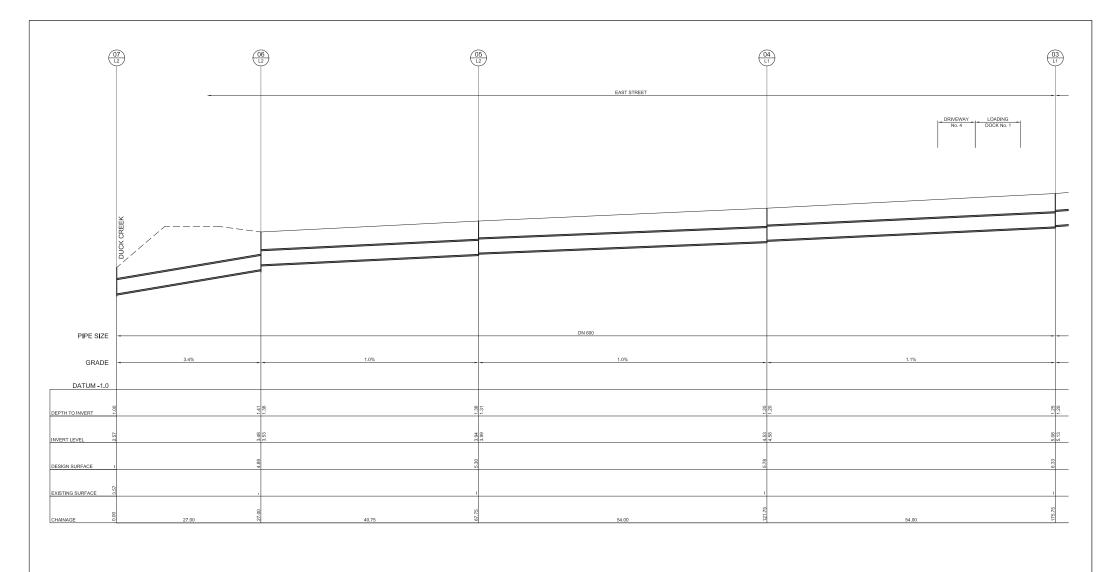


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of MARCHESE PARTNERS ENGINEERING PTV. L					Level 1, 53 Walker Street, North Sydney, NSW 2060, Australla P+61 2 9922 4375 F+61 2 9929 5786 E Info@marchesepartners.com.au www.marchesepartners.com.au		PROJECT 14-38 COWPER ST. 21-41 EAST ST.	SCALE AS SHOWN	DATE 10.11.2016	DRAWN TF	CHECKED LP
DEVELOPMENT APPLICATION					Sydney • Brisbane • Canberra • Melbourne • Adelalde • Perth Kuala Lumpur • Auckland ABN 32 604 104 378	0 1 2 3 4 5 10 1:250	5-5A ROWELL ST GRANVILLE NSW 2142		DRAWING DA-C-321		REVISION D

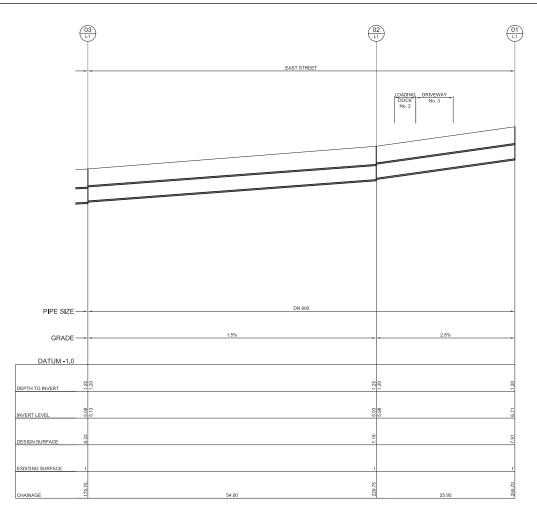


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DEVELOPMENT	Level 1, 53 Walker Street, North Sydney, NSW 2660, Australla P+612 9922 4375 F+612 9929 578E Ehrößmarchesepartners.com.au www.marchesepartners.com.au Sydney, Efishane - Canberra - Melbourne - Adelalde - Perth		PROJECT 14-38 COWPER ST, 21-41 EAST ST, 5-5A ROWELL ST GRANVILLE NSW 2142	SCALE AS SHOWN JOB	DATE 10.11.2016 DRAWING	DRAWN TF	LP REVISION
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not be retained, copied or used without the express authority	11.16 DEVELOPMENT APPLICATION LP	Marchese Partners Engineering Pty Ltd			STORMWAT	ER LONG SEC		SHEET 3
of MARCHESE PARTNERS ENGINEERING PTY, LTD.		Level 1, 53 Walker Street, North Sydney, NSW 2060, Australia		PROJECT	SCALE	DATE	DRAWN	CHECKED
DEVELOPMENT		P+61 2 9922 4375 F+61 2 9929 5786 E Info@marchesepartners.com.au www.marchesepartners.com.au			AS SHOWN	10.11.2016	TF	LP
		Sydney · Brisbane · Canberra · Melbourne · Adelaide · Perth		5-5A ROWELL ST GRANVILLE NSW 2142	JOB	DRAWING		REVISION
APPLICATION		Kuala Lumpur • Auckland ABN 32 604 104 378	0 1 2 3 4 5 10		0991	DA-C-323		D



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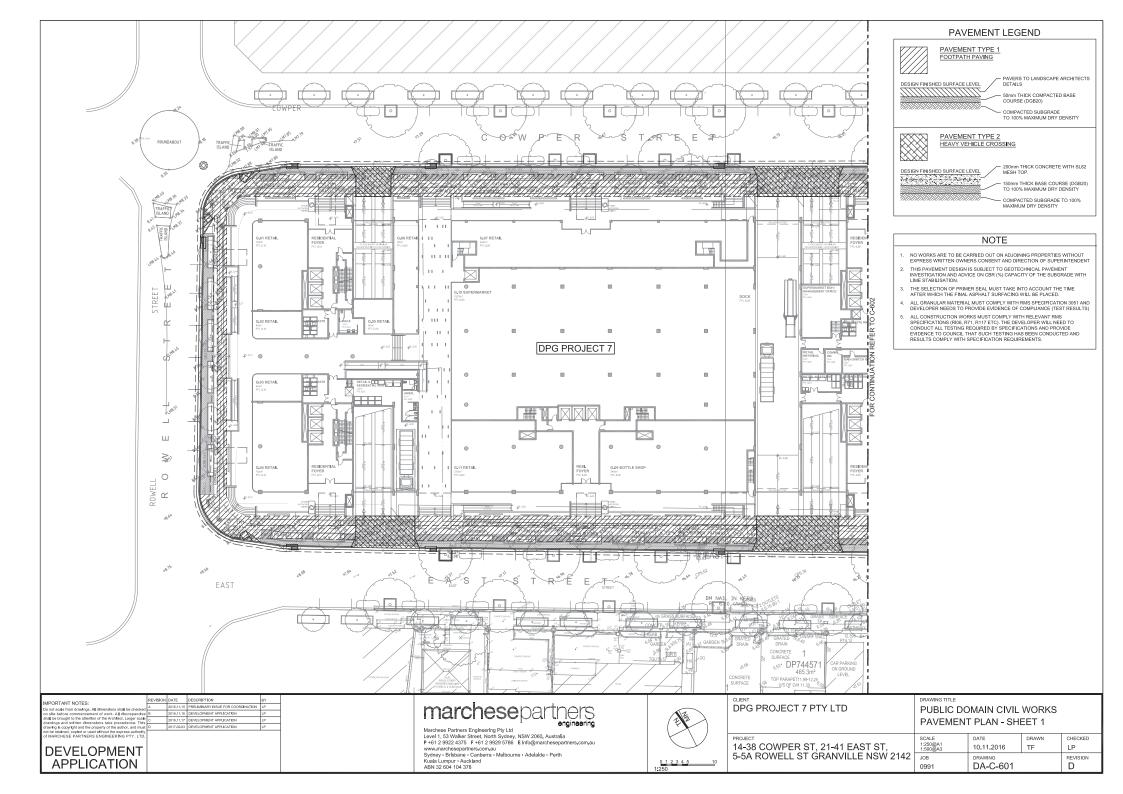
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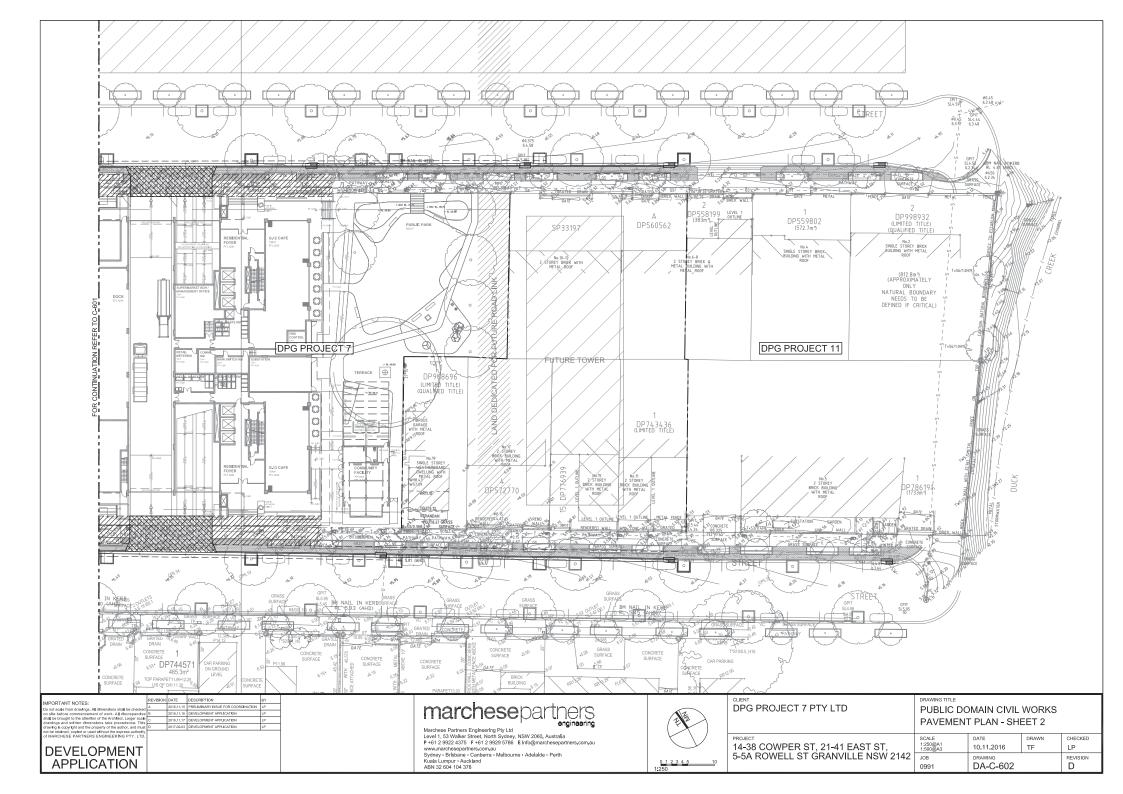
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Do not scale from drawings. All dimensions shall be checked	A	2016.11.15	PRELIMINARY ISSUE FOR COORDINATION	LP
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shall be brought to the attention of the Architect. Larger scale drawings and written dimensions take precedence. This	С	2016,11,20	DEVELOPMENT APPLICATION - DRAFT REVIEW	LP
drawing is copyright and the property of the author, and must		2017.02.03	DEVELOPMENT APPLICATION	LP
not be retained, copied or used without the express authority of MARCHESE PARTNERS ENGINEERING PTY, LTD.				
DEVELOPMENT APPLICATION				

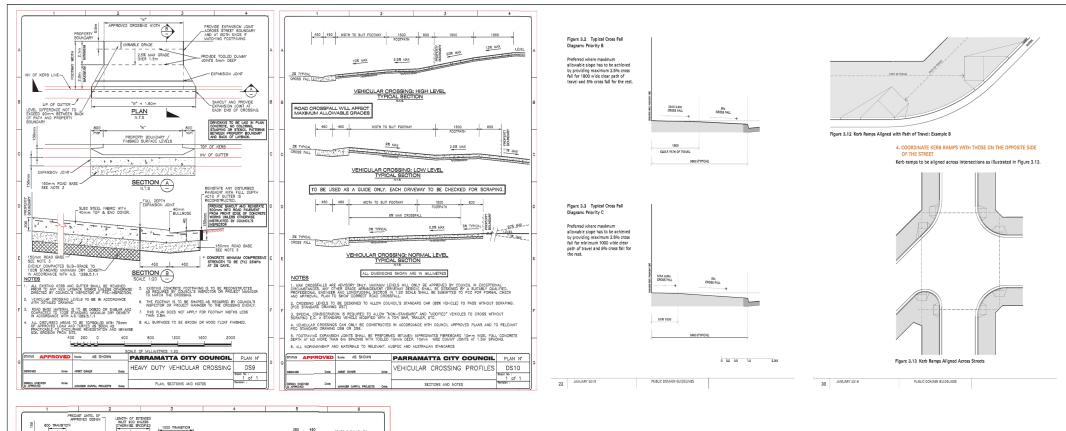
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Marchese Partners Engineering Pty Ltd
Level 1, 53 Walker Street, North Sydney, NSW 2060, Australia
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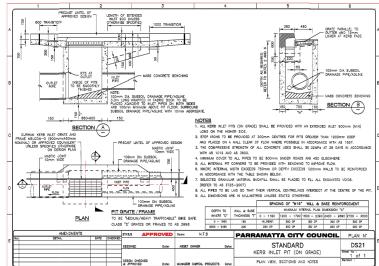
DPG PROJECT 7 PTY LTD	
14-38 COWPER ST, 21-41 EAST ST, 5-5A ROWELL ST GRANVILLE NSW 2142	

	PUBLIC DOMAIN CIVIL WORKS STORMWATER LONG SECTIONS - SHEET 4							
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of MARCHESE PARTNERS ENGINEERING FTV. LTD. DEVELOPMENT		14-38 COWPER ST, 21-41 EAST ST, 5-5A ROWELL ST GRANVILLE NSW 2142	SCALE N.T.S.@A1 JOB	DATE 10.11.2016 DRAWING	TF DRAWN	CHECKED LP REVISION	
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